

RAINFALL INSPECTION NOTE:

ALL EROSION CONTROLS SHALL BE INSPECTED BY A QUALIFIED PERSON WITHIN 24 HOURS OF A RAINFALL EVENT OF 3/4 INCH OR GREATER AND REPAIRED AS NEEDED.

C12.0


1" = 50'

JAN 2022

SCALE:

DATE:

REMOVE SILT FENCE
 PROJECT COMPLETE, FINAL INSPECTION, FILE NOTICE OF TERMINATION

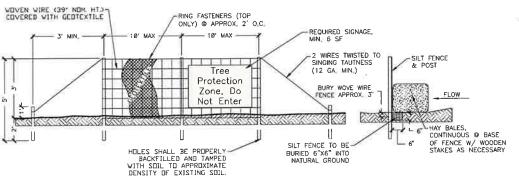

- 1. FENCING TO BE INSTALLED PRIOR TO CONSTRUCTION, FENCING TYPE SHALL BE SILT FENCE & HAY BALES, NO ENTRY, STORAGE, TEMPORARY PARKING, OR DISTURBANCE IS ALLOWED WITHIN THE PROTECTED AREA.

  2. THE FENCE SHALL BE ERECTED W/ A MIN, DISTANCE OF 20', FROM THE TRUNKS OF HERTIAGE TREES & 10' FROM ALL OTHER RETAINED TREES, IF INSTALLING UNDERGROUND UTILITIES NEAR TREE ROOTS BECOMES A HARDSHIP, A SOIL AUGER SHALL BE USED TO TUNNEL UNDER TREE ROOTS.

  3. ALL ROOTS TO BE REMOVED DURING SITE CLEARING &/OR CONSTRUCTION SHALL BE SEVERED CLEARING &/OR CONSTRUCTION SHALL BE SEVERED CLEARING WHERE LARGE OF THE PROTECTE PRODUS.

  4. FOOTERS FOR WALLS SHALL END AT THE POINT WHERE LARGE ROOTS ARE ENCOUNTERED, AND THE POOTS SHALL BE BRIDGED, POST HOLES AND TRENCHES LOCATED CLOSE TO RETAINED TREES SHALL BE ADJUSTED TO A VOID DAMAGE TO MAJOR ROOTS.

  5. FENCING CANNOT BE REMOVED UNTIL LAND ALTERATION, SITE CLEARING, AND CONSTRUCTION ACTIVITIES ARE COMPLETE.

  6. TREE PROTECTION SIGNAGE TO BE A MINIMUM OF 6 SQUARE FEET READING "Tree Protection Zone, Do Not Enter"

PRINCIP.	DBH	gty	TOTAL DBH	TREE CREDITS
SPECIES		96,18		THE COLUMN
CIAK	6		6	1
DAX	7	1	7	1
OAK	8"	3	24	
OAX	9"	4	35	8
OAX	10"	4	40	8
OAK:	111*	1	n	2
OAK	14"	1	14	3
OAK	16"	1	16	3
OAK	17	1	17	3
MAGNOLIA	17	1	17	3
PINE TREE	12	2	24	4
PINE TREE	13"	1	13	3
PINE TREE	14"	3	42	9
PINE TREE	15"	5	75	15
PINE TREE	16"	2	32	6
PINE TREE	IT	1	17	3
PINE TREE	19"	1	19	3
PINE TREE	23*	1	23	4
	TOTAL	34	423	85

6 inches or greate

30 - 35 inches 26-29 inches

20-25 inches

8 - 12 inches

PINE TREE PINE TREE PINE TREE

SE REPLACEMENT CALC	EPLACEMENT CALCULATIONS			
***************************************	CAL	TOTAL DBH	IR	
EES REQUIRED	3	77*	2	
IE CREDITS EARNED				

TREES REQUIRED	3	77	26
THE CREDITS EARNED			85
TOTAL REPLA	ACEMENT TREES	TO BE PLANTED:	.0
AN DEBLACABLET TOFFS	SHALL RE 17 HT.	WITH A OF CALL	

TREE PROTECTION FENCE - GULF SHORES 1/2' = 1'-0"


## TREE PROTECTION LEGEND

- FINE TREES TO BE REMOVED
- X OAK TREES TO BE REMOVED
- MAGNOLIA TO BE PRESERVED
- PINE TREES TO BE PRESERVED OAK TREES TO BE PRESERVED
- TREE PROTECTION ZONE
- TREE PROTECTION FENCE

## TREE PROTECTION NOTES

TREES SHOWN TO BE REMOVED ON THE PROPOSED LOT ARE NOT INCLUDED IN TREE REMOVAL CALCULATIONS, ALL TREES SHOWN TO BE REMOVED WHICH ARE IMPACTED BY PROPOSED INFRASTRUCTURE OR SHOWN OUTSIDE OF THE PROPOSED LOT ARE INCLUDED IN TREE REMOVAL CALCULATIONS.

800-292-8525 #DIG (Cellular) Dig Safely. *Alabama* 

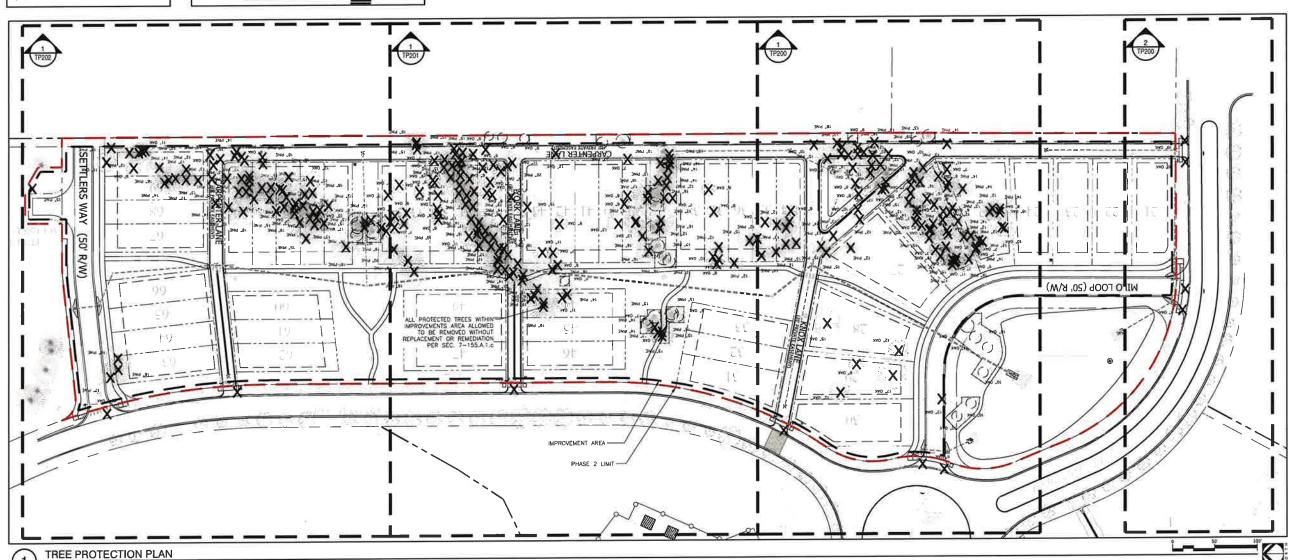





₽ **८** ₽ A Landscape Development Plan 10.

Traditions Phase 2. \*\* Shores, Alabam


levia	ons	
la.	Date	Revisions / Submissions
	11.29.21	PERMIT SUBMITTAL
	01.07.22	PERMIT RESUBMITTAL
-		
_		) <del></del>
_		
_		
_		

518

213354-004 Project No.

11.22.21

TREE PROTECTION **PLAN** 

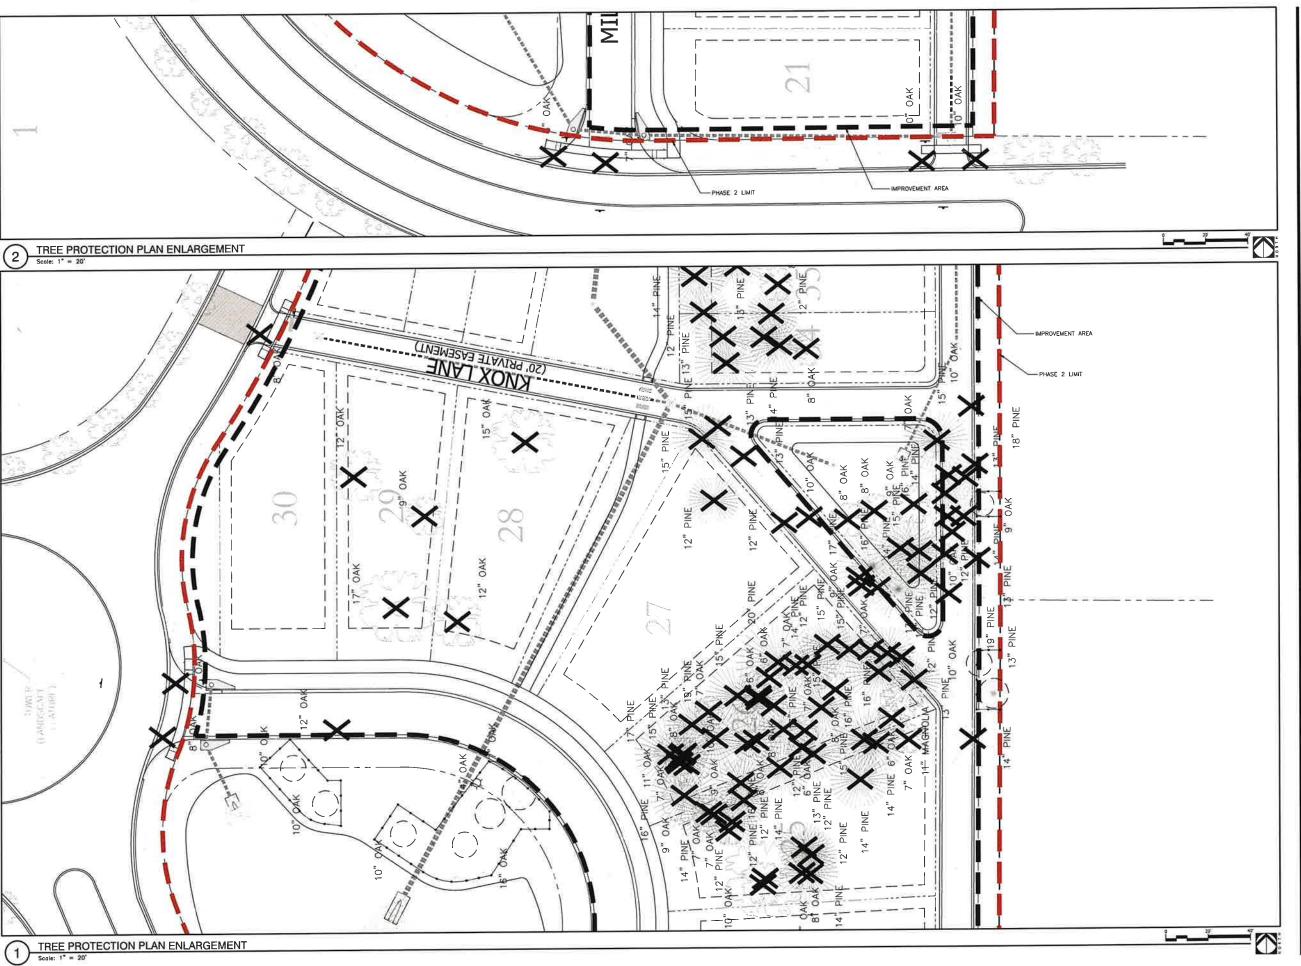





A Landscape Development Plan for Traditions Phase 2 Gulf Shores, Alabama

Revisi	TO	
No.	Date	Revisions / Submissions
_	11.29.21	PERMIT SUBMITTAL
_	01.07.22	PERMIT RESUBMITTAL
_		
_		
- 7		
_		
_		
_		

Copyright 2021 WAS Design Inc. These documents and their contents are the property of WAS Design. Any reproductions, revisions, modifications or use of these documents without it express written consent of WAS Design is prohibited by low.


YJ
Drawn
DM
Froject Monoger
CW
Principol
213354-004
Project No.
11.22.21
Data



\_\_\_\_

TREE PROTECTION
PLAN
ENLARGEMENT

Sheet No.

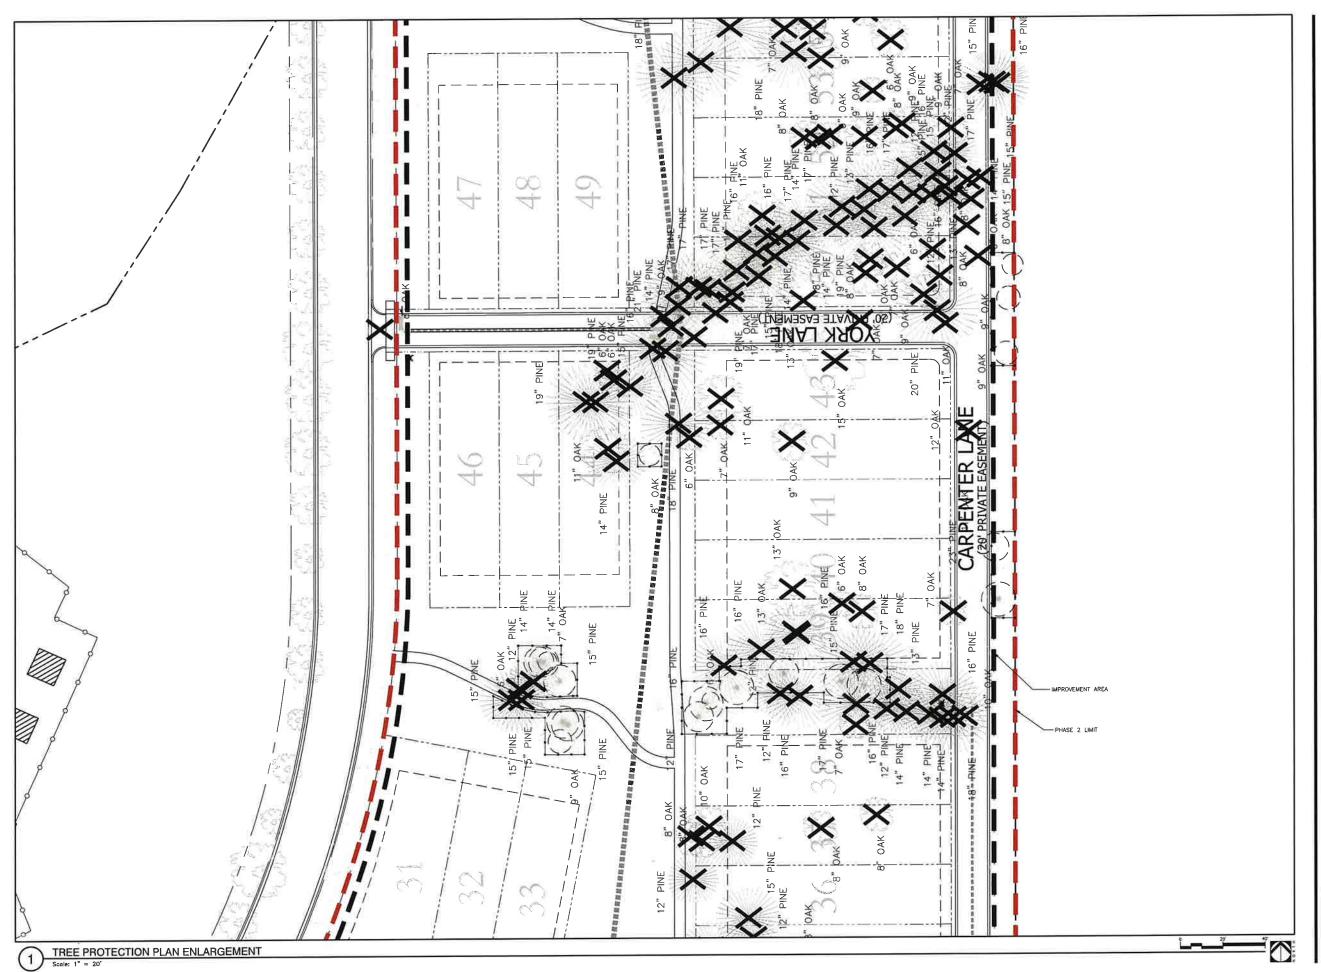



POR CONSTITUCTION
THESE PLANS HAVE NOT BEE
APPROVED AND ARE SUBJECT

Landscape Development Plan for Traditions Phase 2 Gulf Shores, Alabama

		Subert estables.
No.	Date	Revisions / Submissions
_	11.29.21	PERMIT SUBMITTAL
_	01.07.22	PERMIT RESUBMITTAL
_		
-		
_	_	


Copyright 2021 WAS Design Inc. These documents and their contents are the property of WAS Design. Any reproductions, revisions, modifications or use of these documents without in express written consent of WAS Design is prohibited by low.

Order  Order	Registration  OF ALAD  USSES  CHAPTER  AND SCAPE AND SCA

Sheet Title

TREE PROTECTION
PLAN
ENLARGEMENT

Sheet No.

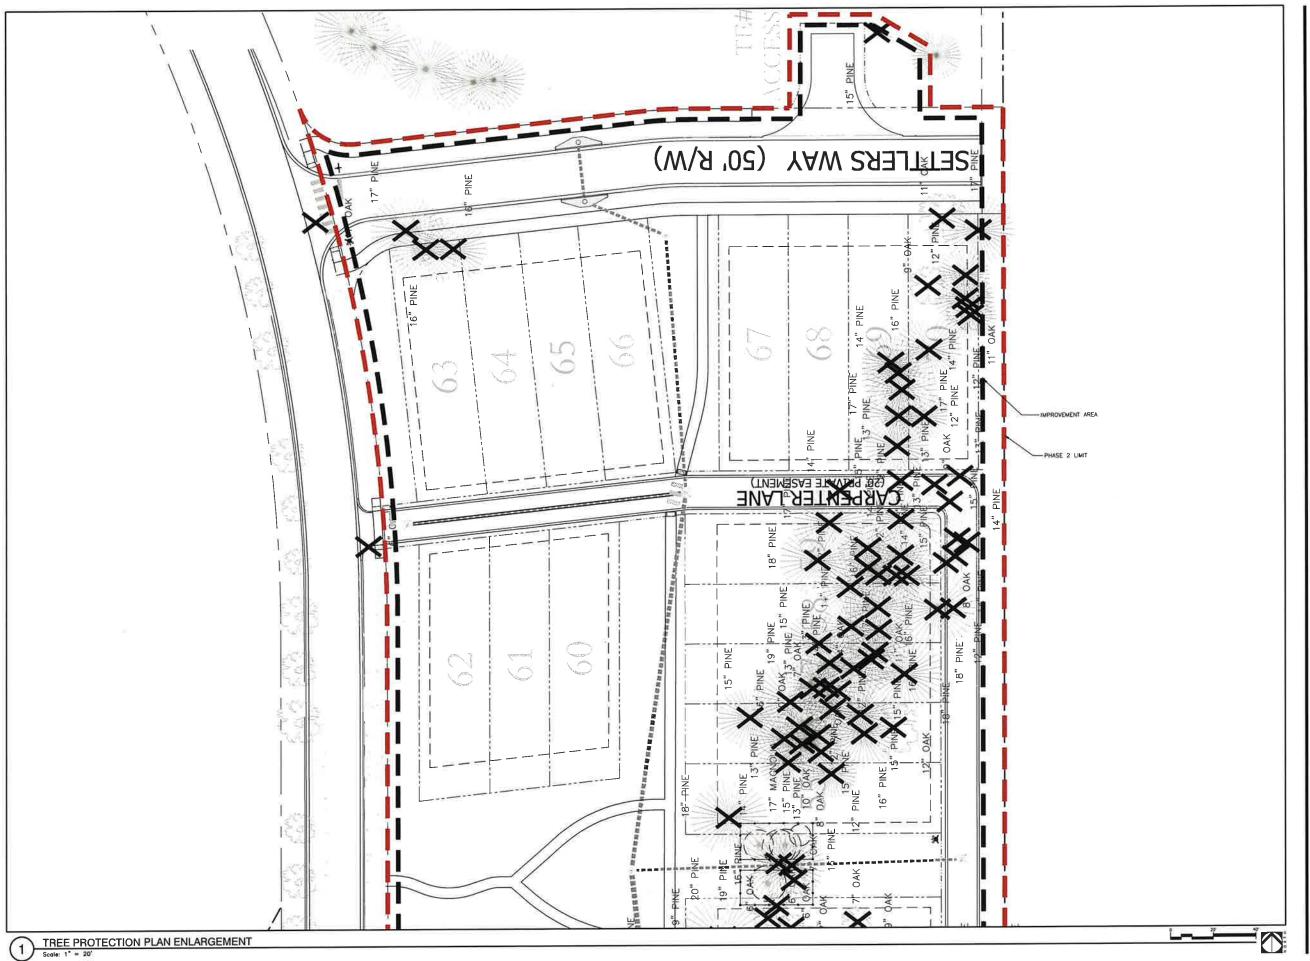



Ravissi		
No.	Date	Revisions / Submissions
	11,29.21	PERMIT SUBMITTAL
_		PERNIT RESUBMITTAL
_		
_		
_	_	
-		
_		
_		



213354-004 Project No. 11.22.21


TREE PROTECTION PLAN **ENLARGEMENT** 

		DULE					
TREES	CODE	QTY	BOTANICAL / COMMON NAME	CONT	CAL	<u>HT</u>	
$\odot$	LN	13	LAGERSTROEMIA INDICA "NATCHEZ" / NATCHEZ "CRAPE MYRTLE STANDARD TRUNK; FULL HEAD	30 GAL	1.5"CAL	8,	
·)	QV	44	QUERCUS VIRGINIANA / SOUTHERN LIVE OAK FULL HEAD, SPECIMEN QUALITY	30 GAL	3"CAL	12	
$\left( \cdot \right)$	TD	35	TAXODIUM DISTICHUM / BALD CYPRESS FULL HEAD, SPECIMEN QUALITY	30 GAL	3"CAL	12	
SHRUBS	CODE	QTY	BOTANICAL / COMMON NAME	CONT	<u>HT</u>	w	SPACING
$\odot$	IN	141	ILEX VOMITORIA NANA' / DWARF YAUPON HOLLY	3 GAL			36" o.c.
0	MS4	119	MISCANTHUS SINENSIS "ADAGIO" / ADAGIO EULALIA GRASS	3 GAL			42" o c
0	SB	117	VIBURNUM ODORATISSIMUM / SWEET VIBURNUM	3 GAL			48" o.c.
SOD/SEED	CODE	QTY	BOTANICAL / COMMON NAME	CONT	HT		
	SOD	93,657 SF	CYNODON DACTYLON "TIFWAY 419" / TIFWAY 419 BERMUDA GRASS	SOD			

STREET FROM	TAGE REQUIR	EMEN	ITS (12-1,0	0)
AL-59				
1 tree pe	25 LF ROW	@	1256 0 LF =	50 24 trees
	Total Frontage	Trees	Required:	50 trees
	*Total Frontage	Trees	Provided:	41 trees
6 shrubs per	20 LF ROW	@	1256 0 LF =	376 80 shrubs
	Fotal Frontage S	h ru bs F	Required:	377 shrubs
	Total Frontage S	hrubs	Provided:	377 shrubs
RETENTION/E	ETENTION LA	NDSC	APE REQ	UIREMENTS (Section 6-6 C-6)
3 tree per	100 LF	@	698.0 LF =	20 94 trees
	Total Perimeter	Trees	Required:	21 trees
	Total Perimeter	Trees	Provided:	21 trees
*Existing preser	ved treesaccour	ıt aspr	ovided tree	s.



IRRIGATION NOTE:
ALL LANDSCAPE AREAS SHALL HAVE
AN AUTOMATIC, UNDERGROUND
IRRIGATION SYSTEM THAT SHALL
PROVIDE 100% HEAD—TO—HEAD
COVERAGE.

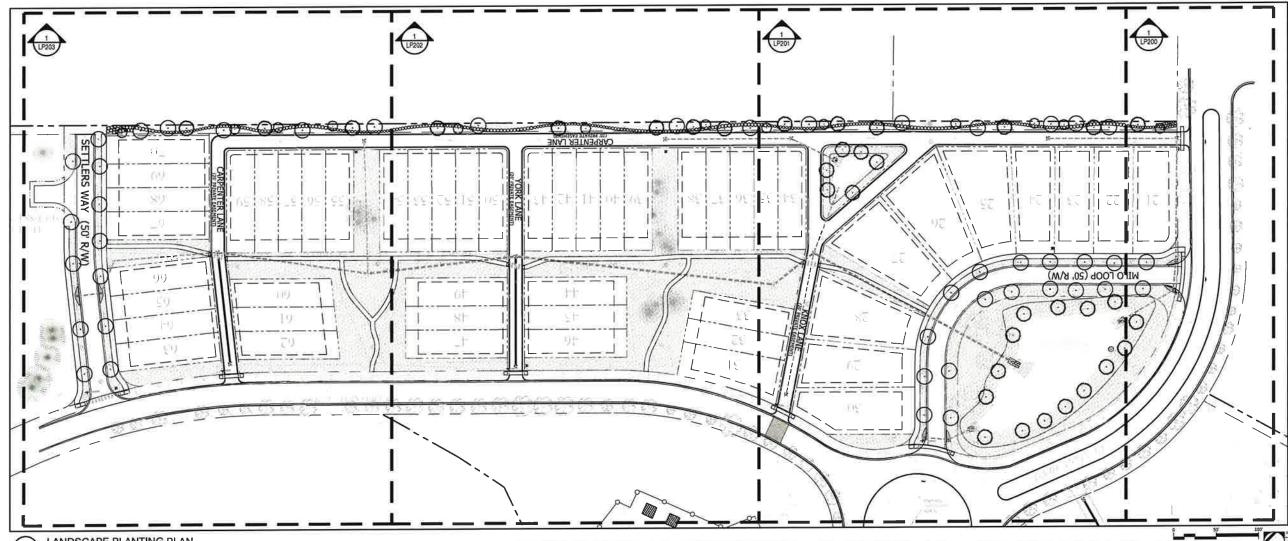





A Landscape Development Plan for Traditions Phase 2 Guif Shores, Alabama


No.	Date	Revisions / Submissions
	11.29,21	PERMIT SUBMITTAL
_	01.07.22	PERMIT RESUBMITTAL
-		
_		
_		
_		
_		
_		



LANDSCAPE PLANTING PLAN

LP100

1 LANDSCAPE PLANTING PLAN
Scole: 1" = 50'

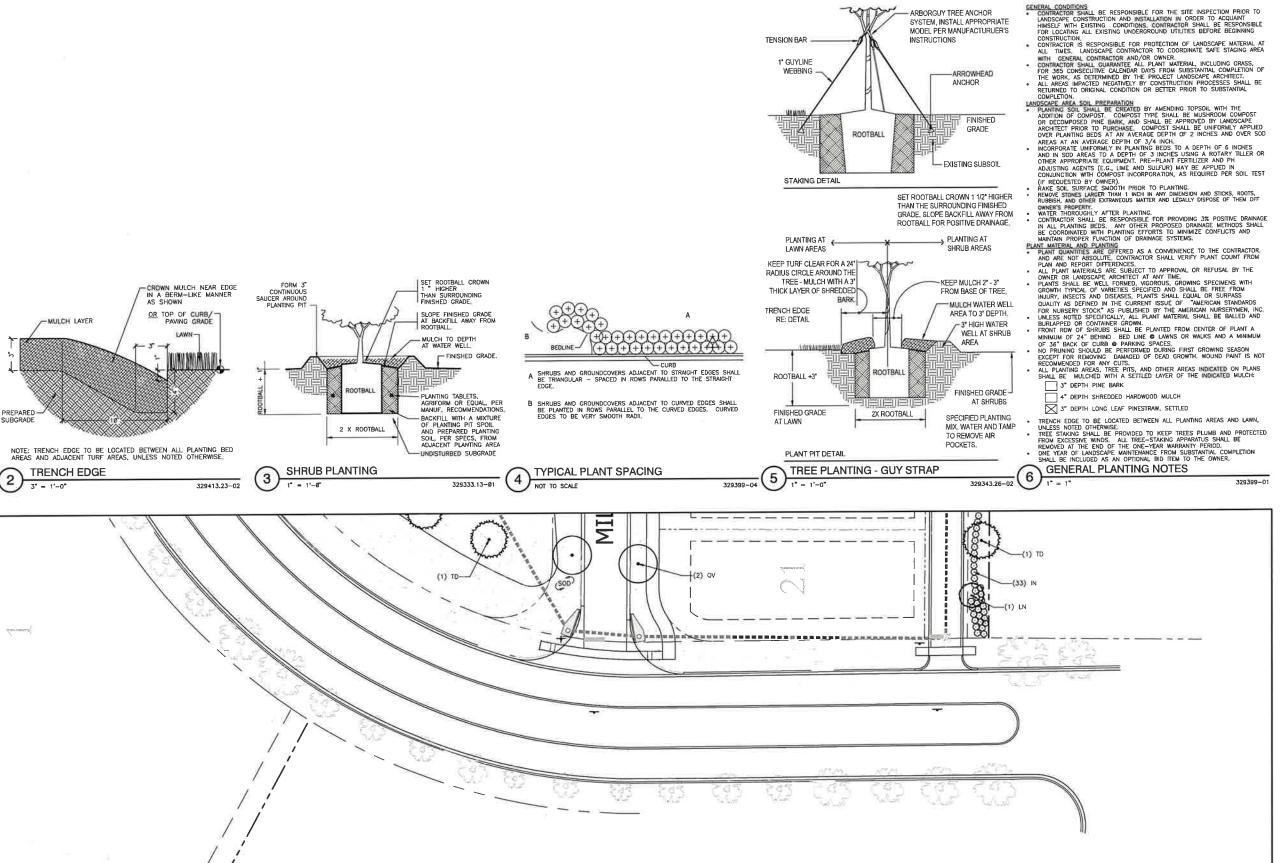

LANDSCAPE PLANTING PLAN ENLARGEMENT

- ARBORGUY TREE ANCHOR



FOR CONSTRUCTION

\$ CD & Phase Alaban Developm **Traditions** 

Revisio	rai	
No.	Date	Revisions / Submission
_	11.29.21	PERMIT SUBMITTAL
	01.07.22	PERMIT RESUBMITTAL
	-	
_		
_		

213354-004 Project No.



11.22.21

LANDSCAPE PLANTING PLAN **ENLARGEMENT** 

LP200